



APPENDIX 3

UPDATED BESS DRAWINGS PROVIDED BY TLI GROUP

(ENCLOSED SEPERATELY)





Schedule of Planning Drawings

Drawing No.	Drawing Title	Scale	Page Size	
	TLI Group			
05990-DR100	Site Location Map	1:5000	A1	
05990-DR101	Site Layout Key Plan Sheet 1 of 2		A1	
05990-DR103	Site Layout Plan Sheet 1 of 9		A1	
05990-DR104	Site Layout Plan Sheet 2 of 9		A1	
05990-DR112	220kV GIS Substation		A1	
05990-DR113	Substation Compound Elevations		A 0	
05990-DR134	Battery Container - Plan Elevations & Section		A 3	

Site Location Map

Scale: 1:5000

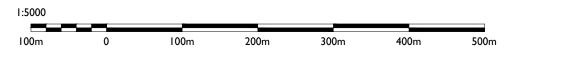

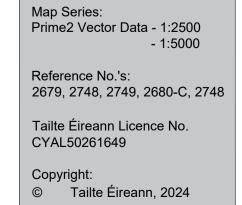



Head Office
Beenreigh,
Abbeydorney,
Tralee, Co. Kerry
Ireland
Tel: 00353 66 7135710

Regional Office
Basepoint Business Centre
Stroudley Road, Basingstoke,
Hampshire,
RG24 8UP, UK
Tel: 00 44 1256406664

ROJECT

Clonberne Wind Farm 220kV Grid Connection

CLIENT

Clonberne Windfarm Limited

CONSULTANTS

NOTES: -

Path of cable route and location may vary depending on site conditions.

 Other services may be encountered along the route.

3. Layout and Arrangements of Substation Building and Electrical Equipment is shown indicatively and for illustration purposes only.
4. Dimensions shown are as per current Eirgrid Specifications at the time of submission. Dimensions may vary at time of construction to reflect any revisions to Eirgid Specififications

5. This drawing is to be used only for the purpose of the planning application and is subject to detailed design.LEGEND: -

LOLIND. -

220kV Substation

Cable Access Track
Public Road Corridor

Accommodation Area

Underground Cable

Operational Accesss

Existing 220kV Overhead Line

Proposed Overhead Line
Cable Compound

Existing 220kV Tower

Proposed Angle Mast

Planning Application Boundary

Finished Compound Level

ISSUE/REVISION

P2	02.12.25	Issued for Plannning
P1	04.06.24	Issued for Plannning
I/R	DATE	DESCRIPTION

PROJECT NUMBER

05-990

SHEET TITLE

Site Location Map

SHEET NUMBER

05990-DR-100

ct Management Initials: Designer: JF Checked: AC Approve

05990-DR-101

Site Layout Plan

Scale: 1:500

SHEET TITLE

Sheet 1 of 9

SHEET NUMBER

05990-DR-103

Site Layout Plan

Reference No.'s: 2679, 2748, 2749, 2680-C, 2748

Tailte Éireann Licence No. CYAL50261649

Copyright: © Tailte Éireann, 2024

Site Layout Plan

Scale: 1:500

Site Layout Plan

Sheet 2 of 9


SHEET NUMBER

05990-DR-104

Tailte Éireann Licence No. CYAL50261649

© Tailte Éireann, 2024

Copyright:

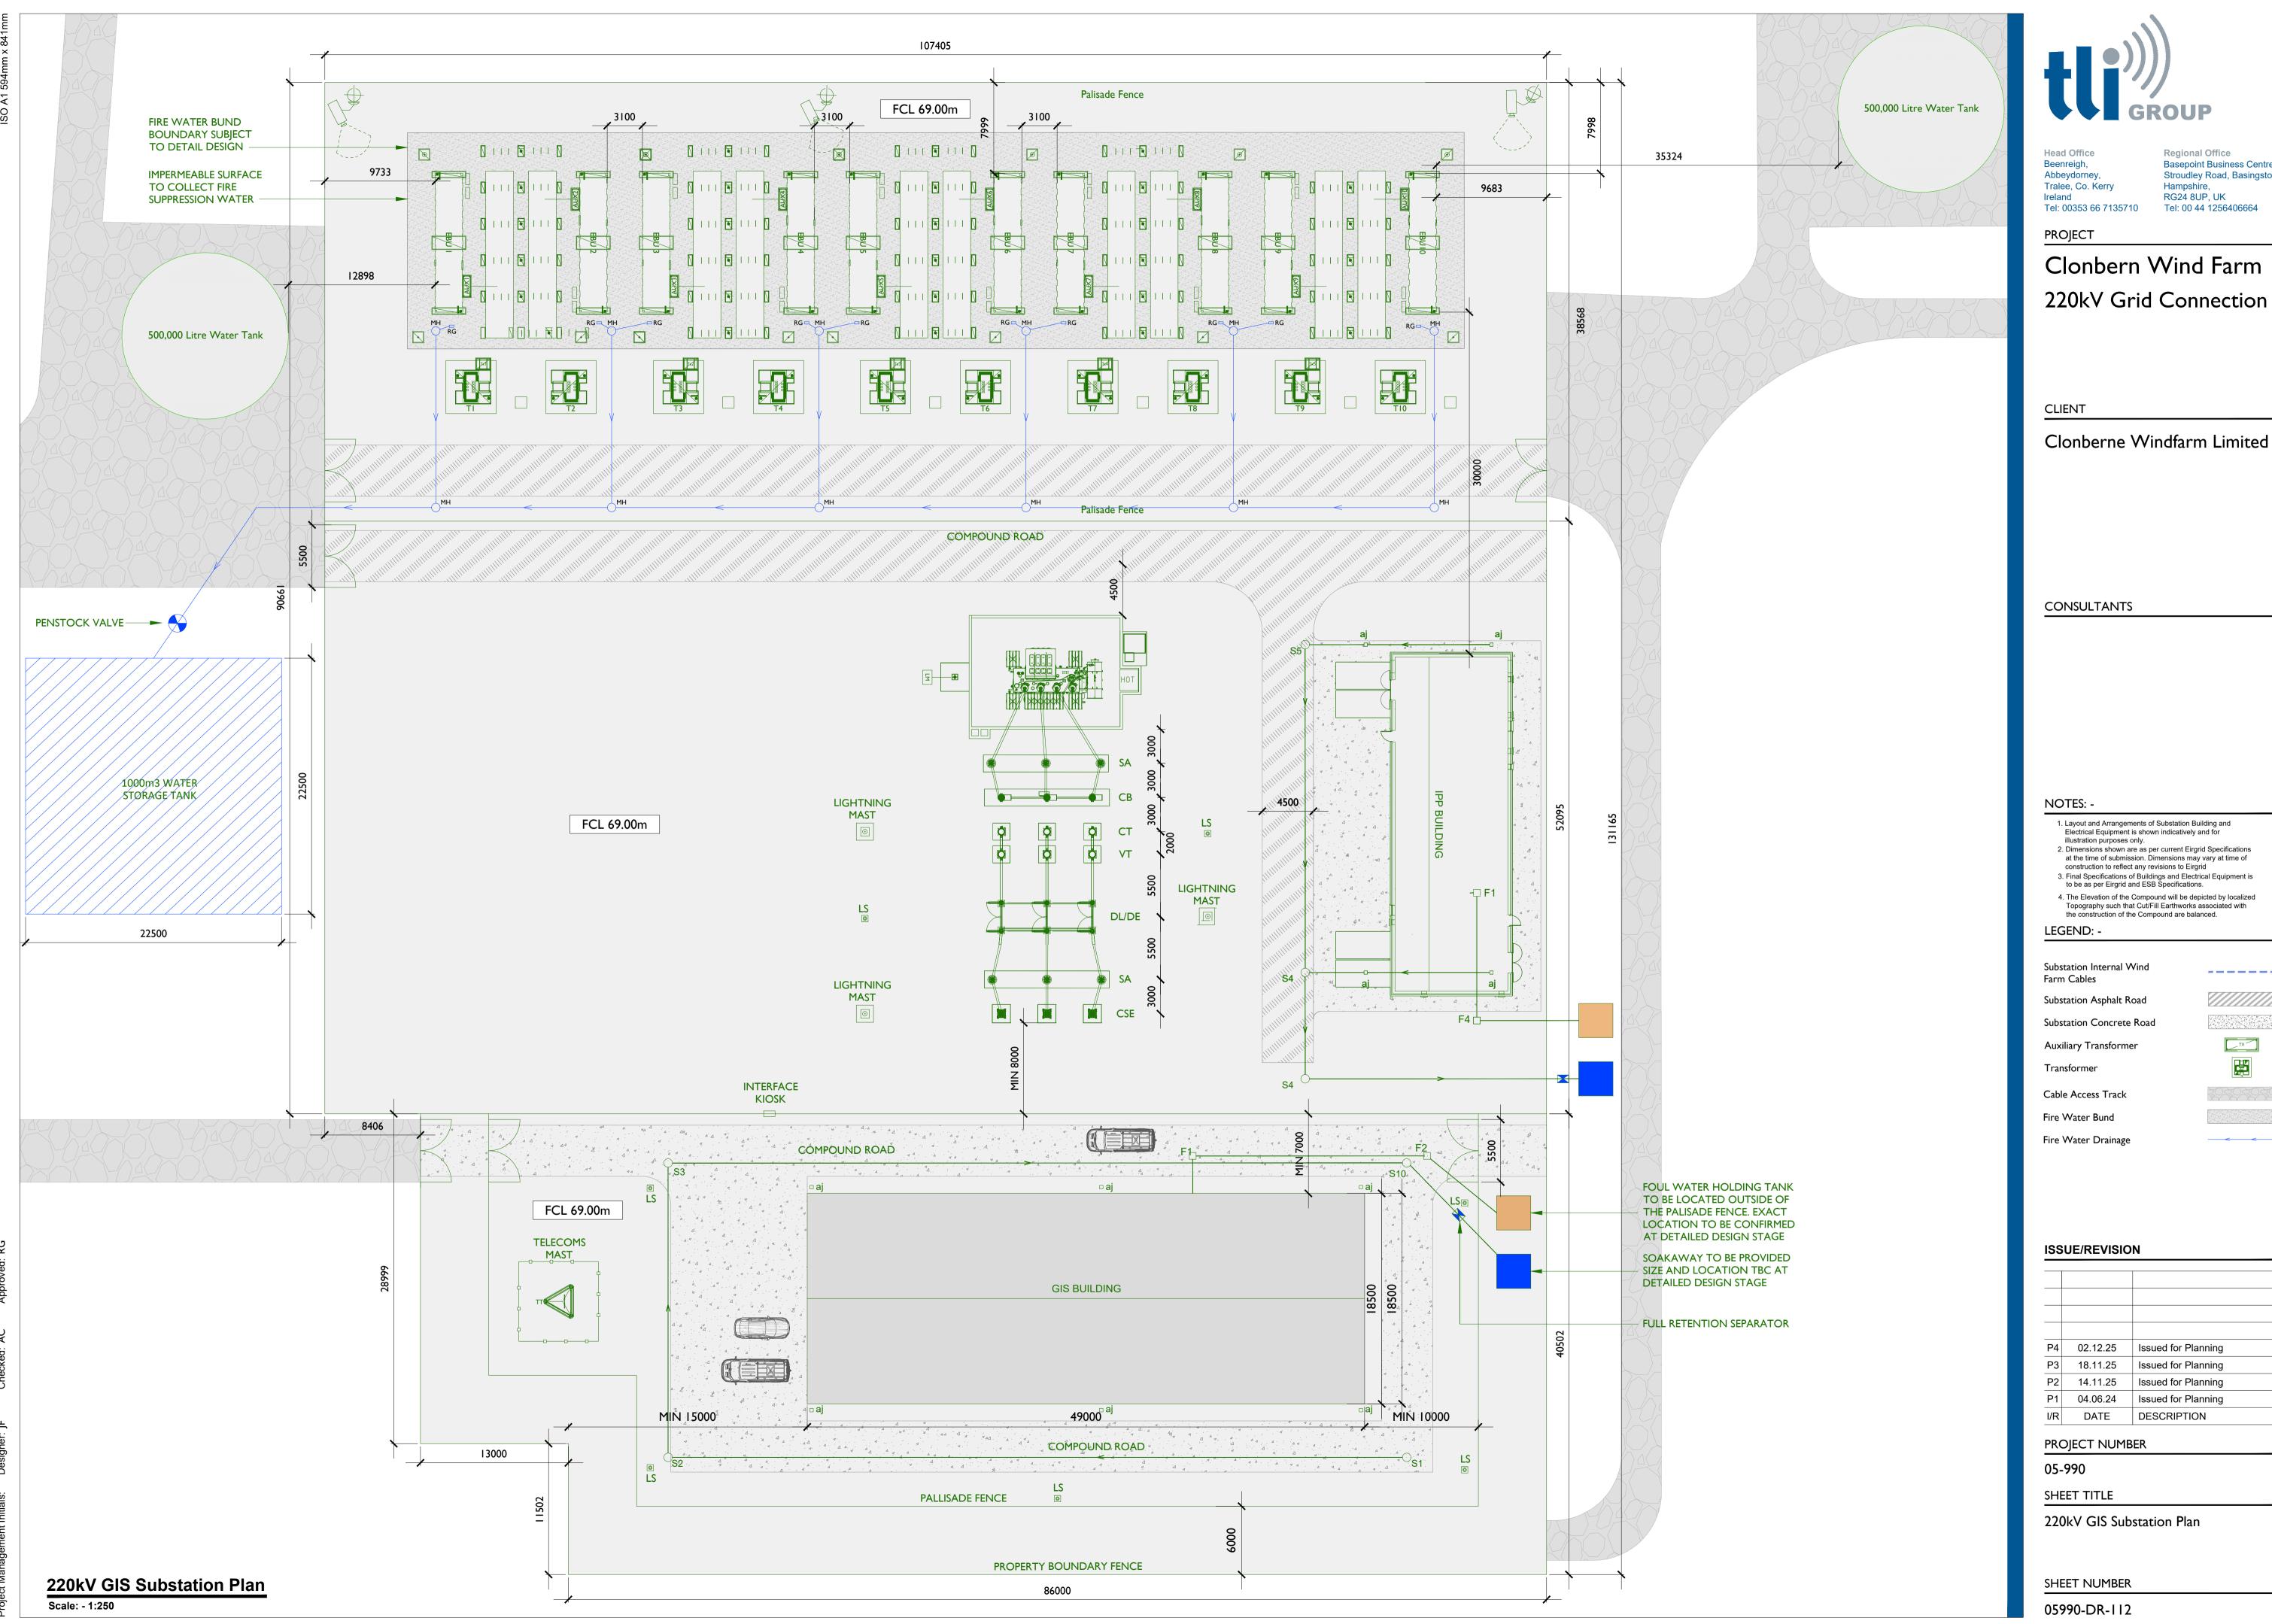

Regional Office Basepoint Business Centre Stroudley Road, Basingstoke, RG24 8UP, UK

Clonbern Wind Farm

4. The Elevation of the Compound will be depicted by localized Topography such that Cut/Fill Earthworks associated with

P4	02.12.25	Issued for Planning
Р3	18.11.25	Issued for Planning
P2	14.11.25	Issued for Planning
P1	04.06.24	Issued for Planning
I/R	DATE	DESCRIPTION

South East Elevation

Scale: 1:250

Regional Office
Basepoint Business Centre
Stroudley Road, Basingstoke, Tralee, Co. Kerry Ireland RG24 8UP, UK
Tel: 00353 66 7135710 Tel: 00 44 1256406664

Clonberne Wind Farm 220kV Grid Connection

Clonberne Windfarm Limited

CONSULTANTS

 Layout and Arrangements of Substation Building and Electrical Equipment is shown indicatively and for illustration purposes only. 2. Dimensions shown are as per current Eirgrid Specifications at the time of submission. Dimensions may vary at time of construction to reflect any revisions to Eirgid Specififications Final Specifications of Buildings and Electrical Equipment is to be per Eirgid and ESB Specifications The Elevation of the Compound will be depicted by localized Topography such that Cut/Fill Earthworks associated with the construction of the Compound are balanced

LEGEND: -

	Description
CSE	Cable Sealing End.
SA	Surge Arrester.
DL/DE	Line / Earth Disconnect.
VT	Voltage Transformer.
СТ	Current Transformer.
СВ	Circuit Breaker.
LM	Lightning Mast.

ISSUE/REVISION


,	РЗ	02.12.25	Issued for Planning
	P2	14.11.25	Issued for Planning
,	P1	04.06.24	Issued for Planning
·	I/R	DATE	DESCRIPTION


PROJECT NUMBER


Substation Compound Elevations

SHEET NUMBER


05990-DR-113

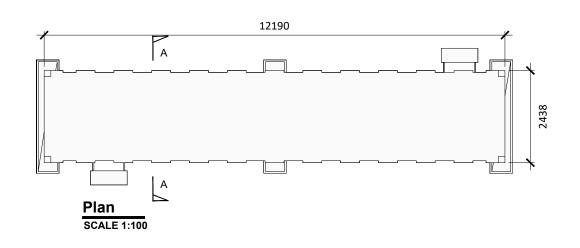

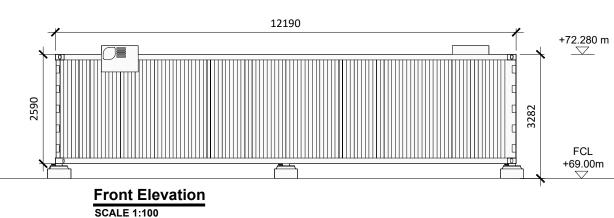


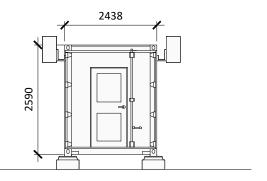

End Elevation
SCALE 1:100

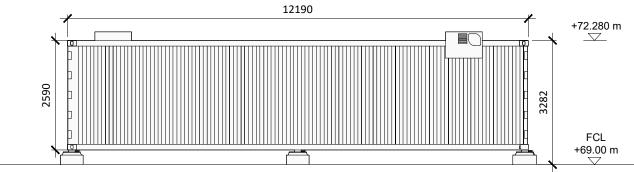

2438

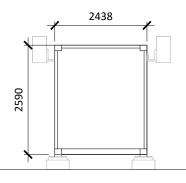

Rear Elevation SCALE 1:100

End Elevation
SCALE 1:100

Section A-A

Note:

- Project contains 10 modules total.
- Dimensions are in millimeters, unless noted otherwise.
- Drawings are not to be scaled use figured dimensions only.
- All Levels in Meters to Malin Head Datum



Head Office Beenreigh, Abbeydorney, Tralee, Co. Kerry Ireland

Tel: 00353 66 7135710

CLIENT

Clonberne Windfarm Limited

Clonberne Wind Farm 220V Grid Connection

PROJECT NUMBER 05-990

SHEET NUMBER 05990-DR-134 SHEET TITLE Battery Container - Plan

Elevations & Section DRAWING STATUS For Planning

ISSUE/REVISION		
P2	02.12.25	Issued for Planning
P1	04.06.24	Issued for Planning
I/R	DATE	DESCRIPTION